

PATRICK O'CARRIGAN + PARTNERS PTY LTD

Address Studio 1, 76 Edwin Street Nth. CROYDON NSW 2132

Tel / Fax (02) 9799 6600 (02) 9799 6011

Email patrick@pocp.com.au Website www.pocparchitects.com.au

ACN 086 693 781

Nominated Architect Patrick O'Carrigan FRAIA NSW ARB # 5025

PROPOSED RESTORATION AND SUBDIVISION OF A LOCAL HERITAGE ITEM

19+21 SOUTH STREET, STRATHFIELD NSW 2135

MAGDALINE MOUAWAD LOT 65+66 DP 8778

FOR MAGDALINE MOUAWAD

FOR DEVELOPMENT APPLICATION JULY 2020

STRATHFIELD COUNCIL RECEIVED

DA2020/124 8 July 2020

PROJECT NO: 180302	DRAWING	TITLE		SCALE SIZE ISSUE		
		COVER PAGE		A3		
		LEGEND			A3	
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	DA 02	EXISTING SITE ANALYSIS			A3	D
	DA 03	EXISTING GROUND FLOOR PLAN + DEMOLITION			A3	D
	DA 04	EXISTING FIRST FLOOR & ROOF PLAN + DEMOLITION			A3	D
DA 05		EXISTING ELEVATIONS + DEMOLITION	1:200	A3	D	
	DA 06	STREETSCAPE ELEVATION EXISTING + PROPOSED		1:300	A3	D
	DA 07		PROPOSED SITE PLAN		A3	E
	DA 08	PROPOSED SUBDIVISION PLAN			A3	A
	DA 09	PROPOSED GROUND FLOOR PLAN			A3	E
	DA 10	PROPOSED FIRST FLOOR PLAN			A3	E
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	DA 12	PROPOSED EAST (FRONT) + WEST (REAR) ELEVATIONS			A3	E
	DA 13	PROPOSED MATERIALS + FINISHES ELEVATION			A3	E
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2-1	DA 16	PROPOSED FRONT FENCE		1:100	A3	С
	DA 17	DIAGRAM GROSS FLOOR AREA + LANDSCAPE AREA		1:200	A3	E
		SURVEY PLAN -	W BUXTON PTY LTD			2
		STORMWATER ENGINEERING PLAN -	ALPHA ENGINEERING AND DEVELOPMENT PTY LTD			В
		SEDIMENT AND EROSION CONTROL PLAN - ALPHA ENGINEERING AND DEVELOPMENT PTY LTD				A
		LANDSCAPE PLAN -	ECOSCAPES PTY LTD			В



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LEGEND	LEGEND	LEGEND	LEGEND	
GENERAL	ELECTRICAL	WALLS	ROOF	
ACR ASHLAR CEMENT RENDER	□ LOW VOLTAGE WALL WASHER	PB PLASTERBOARD	RT ROOF TURBINE	
AC AIR CONDITIONING	O R RECESSED D / L	RBV REVERSE BRICK VERNEER	RWH RAINWATER HEAD	
ADJ ADJUSTABLE	O FLC COMPACT FLUORESCENT	WBD WEATHERBOARD	SP SUSPENDED SET PLASTERBOARD	
BALC BALCONY	INCANDESCENT TUBE PELMET		STU SOLAR TUBE	
BATH BATHROOM	FLUORESCENT TWIN TUBE	WINDOW / DOOR/ LOUVRES/ BALUSTRADE	TBB TIMBER BARGE BOARD	
BOE BRICK ON EDGE		ALD ALUMINIUM FRAMED DOOR	TF TIMBER FINIAL	
BRM BEDROOM	OYSTER FITTING	ALL ALUMINIUM LOUVRES	V VALLEY	
CJ CONTROL JOINT	EXHAUST FAN	ALLS ALUMINIUM LOUVRE SCREEN	VG VALLEY GUTTER	
CL CENTRE LINE	₩ FAN	ALW ALUMINIUM FRAMED WINDOW	VP VENT PIPE	
CLN CLEANERS CUPBOARD	EXIT EMERGENCY LUMINAIRE + BATTERY BACKUP	D DOOR	MODELL ANEQUA	
COR CORRIDOR	SPRINKLER	D/H DOUBLE HUNG	MISCELLANEOUS	
CPBD CUPBOARD CR CEMENT RENDER	├─○ WALL LEVEL LAMP PENDANT LAMP	EGP EXISTING GLAZED PANEL EW EXISTING WINDOW	ALUM. ALUMINIUM BS BASIN	
CR CEMENT RENDER DAR DRESSED ALL ROUND	\P	EW EXISTING WINDOW FG FIXED GLAZING	CTO COOKTOP	
ENS ENSUITE	FAN WEATHER LIGHT DISTRIBUTION BOARD	FGP FIXED GLAZED PANEL	DR DRAWER	
EXTG EXISTING	□ METER BOARD	GB GLAZED BALUSTRADE	F FRIDGE	
GAR GARAGE		GD GLAZED DOOR	FBL FIRE BLANKET	
KB KITCHEN BENCH	LAMP LIGHT POINT STEREO SPEAKER	GL GLAZED LOUVRES	FE FIRE EXTINGUISHER	
KIT KITCHENETTE	KEYPAD SECURITY	HW HOPPER WINDOW	FP FIREPLACE	
LAM LAMINATE	INTERCOM POINT	HWS HARDWOOD SELECT	FW FLOOR WASTE	
LR LOUNGEROOM	INTERCOM LINE	NAGL NEW ALUMINIUM FRAMED GLAZED LOUVRES	GO GOING/ TREAD	
LDY LAUNDRY	SC SECURITY CAMERA	NALS NEW ALUMINIUM LOUVRES SCREEN	GR GRAB RAIL	
OFF OFFICE	DYNALITE CONTROLLER 4 / 6 / 8 BUTTON	NALSS NEW ALUMINIUM LOUVRES SUNSHADE	HC HOSE COCK	
P PAINT FINISH	⊕ CHANDELIER	NASW NEW ALUMINIUM FRAMED SLIDING WINDOW	HWU HOT WATER UNIT	
POR PORCH	© EXTERNAL LIGHTING BOLLARD	NBFD NEW BI-FOLD DOOR	IMP IMPERVIOUS	
SHR SHOWER RECESS	○ DIMMABLE DOWNLIGHT	NBW NEW BAY WINDOW	KBO KICK BOARD	
SEL SELECTED	1515	ND NEW DOOR	KO KERB OUTLET	
SKTG SKIRTING	LEVEL	NFGP NEW FIXED GLAZED PANEL	LFT LAMINATED FLOOR TILE	
S/S STAINLESS STEEL	AFL ATTIC FLOOR LEVEL	NFW NEW FIXED WINDOW	M MIRROR	
ST STORE ROOM	EGL EXISTING GROUND LEVEL	NGB NEW GLAZED BALUSTRADE	OV OVEN	
TER TERRACE	FCL FINISHED CEILING LEVEL	NGL NEW GLAZED LOUVRES	P/C POWDER COATED	
TYP TYPICAL	FFL FINISHED FLOOR LEVEL	NHW NEW HOPPER WINDOW	RI RISER RH RANGEHOOD	
VER VERANDAH VP VENT PIPE	FGL FINISHED GROUND LEVEL GFL GROUND FLOOR LEVEL	NRS NEW ROLLER SHUTTER NSD NEW SLIDING DOOR	RWT RAIN WATER TANK	
VP VENT PIPE VT VENT	GFL GROUND FLOOR LEVEL GRL GUTTER RELATIVE LEVEL		SC SHOWER CURTAIN	
WC TOILET	HEAD TOP WINDOW HEAD	NSWB NEW STAINLESS STEEL WIRE BALUSTRADE NTD NEW TIMBER DOOR	SCR SHOWER CURTAIN RAIL	
W/INR WALK IN ROBE	NGL NEW GROUND LEVEL	NTGP NEW TINTED GLASS PANEL	SDH SOAP DISH HOLDER	
W/R WARDROBE	RL RELATIVE LEVEL TO AHD	NTGS NEW TINTED GLASS FANLE NTGSS NEW TINTED GLAZED SUNSHADING	SI SINK	
WRC WESTERN RED CEDAR	RRL RIDGE RELATIVE LEVEL	NW NEW WINDOW	SM SHOWER MIXER	
WIGH WESTERWINES SESSION	S SILL LEVEL	OG OBSCURE GLASS	SPD SOAP DISPENSER	
STRUCTURAL	SL SLAB LEVEL	RS ROLLER SHUTTER	SR SHOWER ROSE	
CHS CIRCULAR HOLLOW SECTION TO ENG. DETAIL	02 02.15 22.722	SD SLIDING DOOR	SWP STORM WATER PIT	
CONC CONCRETE	FLOOR	SSB STAINLESS STEEL WIRE BALUSTRADE	T TAP	
HDG HOT DIPPED GALVANISED	CFT CERAMIC FLOOR TILE	TB TIMBER BALUSTRADE	TB TOILET BRUSH	
IB UNIVERSAL BEAM / I-BEAM	CPT CARPET	TF TIMBER FRAMED	TOR TOWEL RING	
LVL LAMINATE VENEER LUMBER	ET CLEAR EPOXY MEMBRANE FINISH TO TIMBER	TG TINTED GLAZE	TR TOWEL RAIL	
RC REINFORCED CONCRETE	FLOORING	TLS TIMBER LOUVRES SCREEN	TPH TOILET PAPER HOLDER	
SB GALVANISED ROD STEEL BRACING		TW TIMBER FRAMED WINDOW	VC VANITY CABINET	
SHS SQUARE HOLLOW SECTION	DIRECTION OF FLOW	TD TIMBER DOOR	WM WASHING MACHINE	
STC STEEL TROWELLED FINISHED CONCRETE		W WINDOW	uPVC UNPLASTICISED POLYVINYL CHLORIDE	
TB TIMBER BEAM	MAR MARMOLEUM	WRC WESTERN RED CEDAR	WWW 77/750	
TFJ TIMBER FLOOR JOIST	SKTG SKIRTING	5005	WALL TYPES	
TK 75 x 100mm HARDWOOD KEEN BRACING	SST SELECTED STONE TILE	ROOF ROOM ROY OUTTER	BRICK WORK INFILL	
TP HARDWOOD TIMBER POST TS 75 x 35mm TIMBER STUD FRAME / MPG12	TC TERRACOTTA TCT TERRACOTTA TILE	BG BOX GUTTER	// // // CREATE OPENING ON // // EXTG STRUCTURE	
TT TIMBER TRUSS	T&G TONGUE & GROOVE STRIP FLOORING	BI BULK INSULATION BLANKET & SARKING BR BARGE ROLL METAL COLORBOND	EXISTING WALL	
TI TIMDER TROOS	VYL VINYL FLOOR	CMR COLORBOND METAL ROOF	EXISTING WALL EXISTING WALL ETC. REMOVED	
	VFT VINYL FLOOR VFT VINYL FLOOR TILE	CRF CORRUGATED STEEL ROOF	NEW TIMBER STUD WALL	
ELECTRICAL	PWF PLYWOOD FLOORING	DP DOWN PIPE Ø 75	// NEW 110 BRICKWORK	
EDB ELECTRICAL DISTRIBUTION BOARD		EG EAVES GUTTER	ZZZZZZ NEW 10 BRICKWORK	
POE POINT OF ENTRY POWER	WALLS	ETR EXISTING TILE ROOF	NEW HDG STEEL COLUMN	
SCL SECURITY LIGHT	BV BRICK VENEER WALL	ECOR EXISTING CORRUGATED ROOF		
EXISTING GPO	CBW CAVITY BRICK WALL	EXH EXHAUST		
DOUBLE GPO	C/B COLORBOND	G GABLE		
SINGLE GPO	CFC COMPRESSED FIBRE CEMENT SHEETING	H HIP		
PERMANENT CONNECTION	CR CEMENT RENDER	HCA HIP CAPPING (ROLL TOP)		
× switch	CS COLORBOND STEEL 'CUSTOM ORB' CLADDING	S/L SKYLIGHT `		
X _{2W} 2 WAY SWITCH	CWT CERAMIC WALL TILE	MDR METAL DECK ROOF		
DIMMER SWITCH	EAR EXISTING ASHLAR RENDER	MRC METAL RIDGE CAPPING (ROLL TOP)		
SMOKE DETECTOR TO BCA 3.7.2	ECR EXISTING CEMENT RENDERED	NCRF NEW CORRUGATED ROOF		
TV COAX OUTLET	EFB EXISTING FACE BRICK	NMR NEW METAL ROOF		
TELEPHONE OUTLET	FB FACE BRICK	NTR NEW TILE ROOF		
O LV LOW VOLTAGE D / L	FC 6mm VILLABOARD (FLUSH JOINT)	OF OVERFLOW		
LIGHT SENSOR	NBDP NEW BLUEBOARD RENDER + PAINT	R RIDGE		
DATA POINT	NCR NEW CEMENT RENDER	RG RAKING GUTTER		
		<u> </u>		



MAGDALINE
MOUAWAD
PROJECT NO: 180302

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Schedule of BASIX commitments

The commitments set out below regulate how the proposed development is to be carried out. It is a condition of any development consent granted, or complying development certificate issued, for the proposed development, that BASIX commitments be complied with.

Water Commitments

Rainwater Tank

- The applicant must install a rainwater tank of at least 3521 litres on the site. This rainwater tank must meet, and be installed in accordance with, the requirements of all applicable regulatory authorities.
- The applicant must configure the rainwater tank to collect rainwater runoff from at least 200 square metres of roof area.
- The applicant must connect the rainwater tank to a tap located within 10 metres of the edge of the pool.

Rainwater Tank

- The swimming pool must be outdoors.
- The swimming pool must not have a capacity greater than 60 kilolitres.
- The applicant must install a poll pump timer for the swimming pool.
- The applicant must not incorporate any heating system for the swimming pool that is part of this development.

Hot Water

The applicant must install the following hot water system in the development: gas instantaneous.

Lighting

• The applicant must ensure a minimum of 40% of new or altered light fixtures are fitted with fluorescent, compact fluorescent, or lightemitting-diode (LED) lamps.

Swimming Pool

- The applicant must ensure new or altered showerheads have a flow rate no greater than 9 litres per minute or a 3 star water rating.
- The applicant must ensure new or altered toilets have a flow rate no greater than 4 litres per average flush or a minimum 3 star water rating.
- The applicant must ensure new or altered taps have a flow rate no greater than 9 litres per minute or minimum 3 star water rating.

Thermal Comfort Commitments

Insulation Requirements

- The applicant must construct the new or altered construction (floor(s), walls, and ceilings/roofs) in accordance with the specifications listed in the table below, except that a) additional insulation is not required where the area of new construction is less than 2m2, b) insulation specified is not required for parts of altered construction where insulation already exists.
- External wall: cavity brick nil
- Internal wall shared with garage: plasterboard (R0.36) nil

Glazing Requirements

Skylights

- The applicant must install the skyli8ghts in accordance with the specifications listed in the table below.
- The following requirements must also be satisfied in relation to each skylight:
- Each skylight may either match the description, or, have a U-value and a Solar Heat Gain Coefficient (SHGC) no greater than that listed in the table below:

Skylight Number	Area of Glazing	Shading Device	Frame and Glass Type
S1	1.5	no shading	timber, low-E internal/argol fill/clear external, (or U-value: 2.5, SHGC:0.456)
S2	1.5	no shading	timber, low-E internal/argol fill/clear external, (or U-value: 2.5, SHGC:0.456)
S3	1.5	no shading	timber, low-E internal/argol fill/clear external, (or U-value: 2.5, SHGC:0.456)
S4	1.5	no shading	timber, low-E internal/argol fill/clear external, (or U-value: 2.5, SHGC:0.456)
S5	1.5	no shading	timber, low-E internal/argol fill/clear external, (or U-value: 2.5, SHGC:0.456)

MATERIALS AND FINISHES - EAST (STREETSCAPE) ELEVATION



PRESERVE EXISTING TERRACOTTA TILE



4. RENDERED WALLS PAINTED PRESERVE EXISTING REGENCY WHITE OR SIMILAR



5. FENESTRATION

OR SIMILAR

PRESERVE EXISTING

TIMBER, WHITE ON WHITE

PRESERVE EXISTING TIMBER, WHITE ON WHITE



PRESERVE EXISTING COPPER ROOF



13. GARAGE DOOR PRESERVE EXISTING METAL ROLLER



16. DRIVEWAY PRESERVE EXISTING CONCRETE



17. FENCE PRESERVE EXISTING ROUGH HEWN SANDSTONE BLOCKS, CLEANED



18. BOUNDARY FENCE PROPOSED PRE-FAB PANEL PVC WHITE OR SIMILAR



19. GARDEN WALL GATE PROPOSED TIMBER WHITE OR SIMILAR

CONSERVATION ACTIONS

HOUSE

- 1. Preserve existing terracotta tile roof, clean tiles, re-set and re-point
- Check over and restore existing chimney flashing and seal
- Restore downpipes and gutters to operation
- Preserve and re-paint existing rendered and painted external walls
- Preserve and re-paint existing painted fenestration (repair timber rot)
- Preserve, re-pair and re-paint existing shutters, restore to operational (repair timber rot)
- Preserve existing copper roofs of bay windows
- Clean vine traces off shutters and soffits Re-point sandstone details
- Ease windows to make operational 10.
- 11. Relocate the pocket doors
- 12. Salvage and re-use major windows

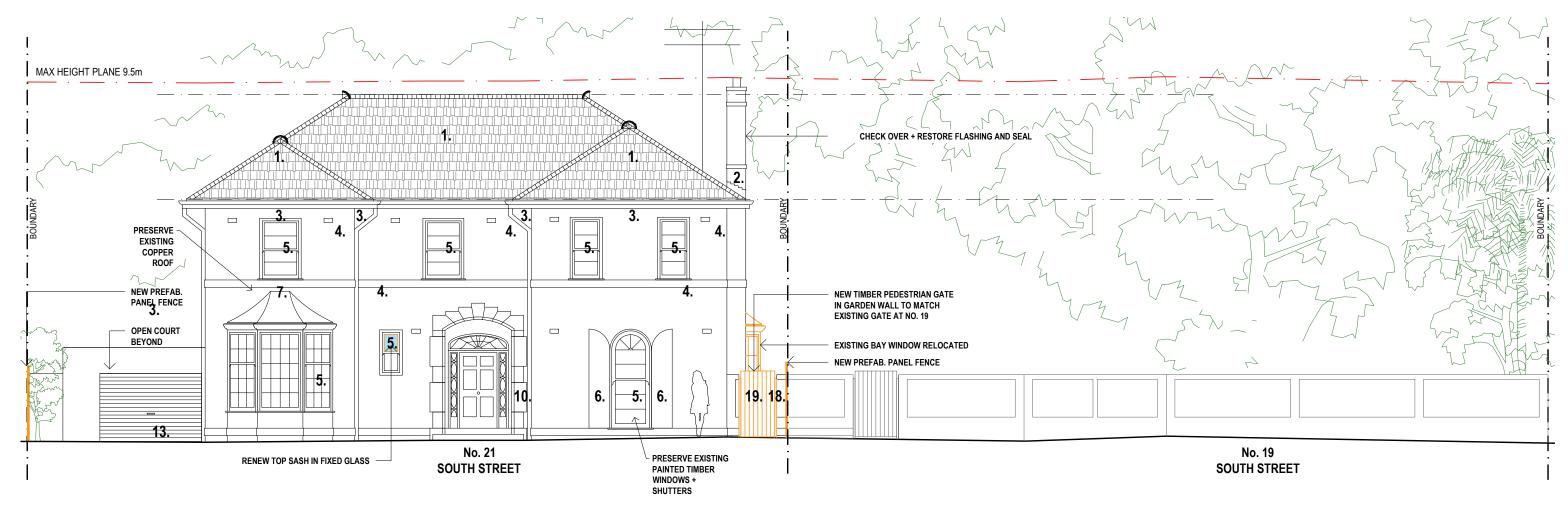
- 13. Upgrade plumbing/ electricals
- 14. Carpet/ wallpapers as appropriate

SETTING

- 15. Restore landscape setting as contemporaneous with the House
- 16. Refurbish front driveway, retain existing location and concrete
- 17. Restore existing sandstone front fence, re-point and clean

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MATERIALS + FINISHES

PROPOSED - 1:100

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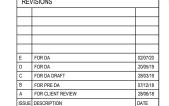
Verify all dimensions and levels on site and report any discrepancies prior to the commencement of work.

Designate of the between the commencement of work.

Use figured dimensions only. Do not scale from drawings.

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TRUE NORTH John and Magdaline Mouawad BUILDER

PROPOSED ALTERATIONS AND RESTORATION TO 19-21 South Street, Strathfield DP 8778 Lot 65 + 66 ARCHITECT POC+P Sydney, Australia T 02 9799 6600

CHECKED/AUTHORISED architects F 02 9799 6011 INITIAL/SIGNATURE

DRAWING TITLE MATERIALS + FINISHES PROPOSED SCALE 1:100 @ A3 PLOT DATE DRAWING NO. 02/07/20 **DA13** PROJECT NO. ISSUE

180302

FOR DA